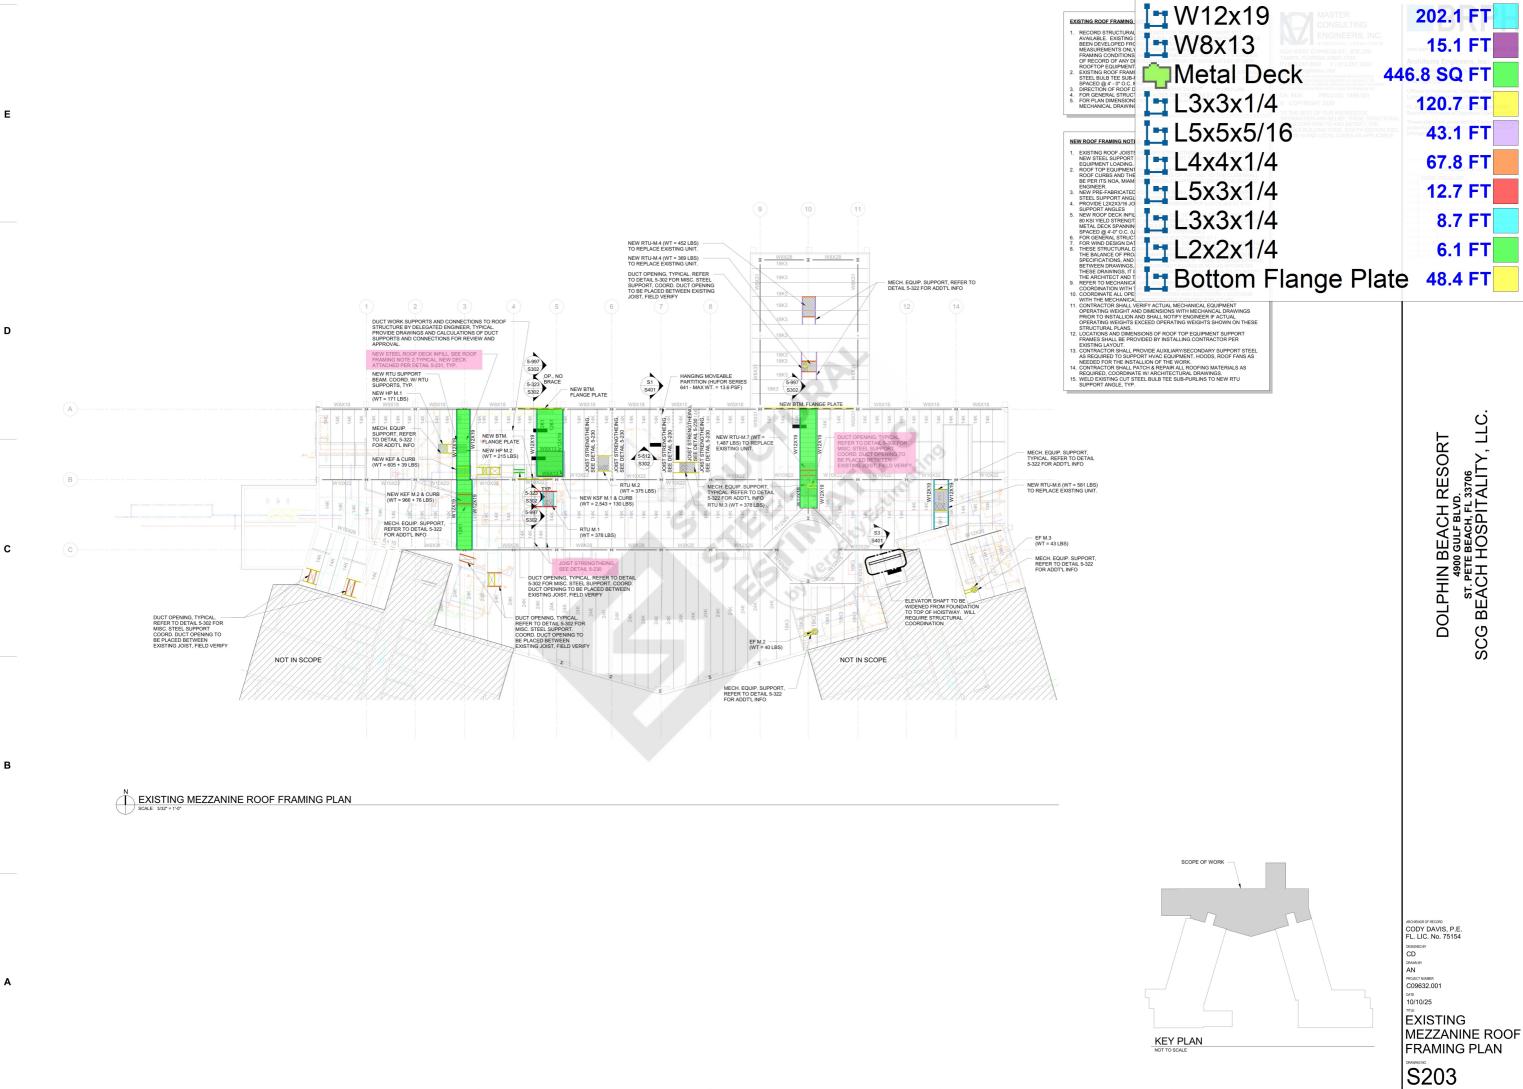
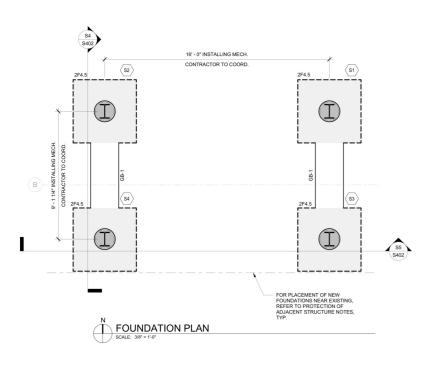
	Building Data Summary	
Project ID:	Dolphin Beach Resort	
Location:	4900 GULF BLVD. ST. PETE BEACH, FL	
Scope of Work:	Structural and misc steel	
Date:		

		·													
Item#	Ref.	Item Description	Unit	Quantity	Wastage	Quantity w/	Unit Material	Total Material	Unit	Hourly wage	Hourly wage	Unit Labor	Total Labor	Sub Cost	Total Trade Cost
	Sheet #			T		Wastage	Cost	Cost	Manhour	(Shop Labor)	(Erect Labor)	Cost	Cost		
		DIVISION.01 GENERAL REQUIREMENTS	1			1		T		1				T. T	
2		Supervision and Coordination Submittals and Shop drawings	LS LS						_					\$ -	
3		Final Cleaning	LS											\$ -	
4		Mobilization Costs	LS											\$ -	
5		Temporary Control & Facilities	LS											\$ -	
- 6 7		On-Site Rental Equipment Lodging - Number of Men x Days	LS 0	0									 	\$ - \$ -	
8		Per Diem - Number of Men x Days	0	0										\$ -	
		Subtotal (General Requirements)													\$ -
		DIVISION 05- Metal													
		Columns													
9		W12x40 (14'-0" H, 4 EA)	Lbs.	2240	5%	2352	\$ -	\$ -	0.000		\$ -	\$ -	\$ -	\$ -	
10		Plate BP-1 Base Plate (18"x18"x1") (4 EA)	Lbs.	395	0%	395	\$ -	\$ -	0.000		\$ -	\$ -	\$ -	. \$ -	
11		Bottom Flange Plate	Lbs.	652	5%	685	\$ -	\$ -	0.000		\$ -	\$ -		\$ -	
		Angles												1	
12		L2x2x1/4 (7 LF) L5x3x1/4 (13 LF)	Lbs.	22 87	5% 5%	23 91	\$ -	\$ -	0.000		\$ -	1 7		· \$ -	
14		L3x3x1/4 (10 LF)	Lbs.	620	5%	651	\$ -	\$ -	0.000		\$ -	\$ -	\$ -	\$ -	
15	4	L4x4x1/4 (68 LF)	Lbs.	474	5%	498	\$ -		0.000		\$ -	\$ -	\$ -	\$ -	
16	S204	L5x5x5/16 (43 LF)	Lbs.	447	5%	469	\$ -	\$ -	0.000		\$ -	\$ -		\$ -	
17	5203	2L4x4x1/4 (37 LF) Beams	Lbs.	515	5%	541	\$ -	\$ -	0.000		\$ -	\$ -	\$ -	\$ -	
18	S	W12X19 (202 LF)	Lbs.	3837	5%	4029	\$ -	\$ -	0.000		\$ -	\$ -	\$ -	\$ -	
19		W8x13 (15 LF)	Lbs.	195	5%	205	\$ -	\$ -	0.000		\$ -	\$ -		\$ -	
20 21		W12x14 (70 LF) W12X26 (107 LF)	Lbs. Lbs.	980 2808	5% 5%	1029 2948	\$ -	\$ -	0.000		\$ -	\$ - \$ -	\$ - \$ -	\$ - \$ -	
- 21		Deck	LU3.	2000	3/6	2340	, -	, ,	0.000		, .	, -	, -	+* -	
22		1-1/2" -18 Guage (447 SF)	Lbs.	1296	5%	1361	\$ -	\$ -	0.000		\$ -	\$ -	\$ -	\$ -	
23			Total Lbs.	14568	5%	15296									
24			Total Tons		5%	7.6482									
					Per#	15,296	\$ -	\$ -					\$ -		\$ -
					Per Ton	7.6482	\$ -						INSURANCE		\$ - \$ -
													CONTINGENCY		\$ -
												OVERHE	AD AND PROFIT		\$ -
													TAX		\$ -
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PROTECTION OF ADJACENT STRUCTURE NOTES:

- PROTECTION OF ADJACENT STRUCTURE NOTES:

 CONTRACTOR SHALL CONDUCT PRE-CONSTRUCTION CONDITION SURVEY OF ADJACENT STRUCTURE.

 EXCAVATION WORK WITHIN 10 FEET OF AN ADJACENT BUILDING MUST BE EXCAVATION WORK WITHIN 10 FEET OF AN ADJACENT BUILDING MUST BE EXECUTED FOR ADJACENT STRUCTURE.

 SHORING SYSTEMS MUST BE DESIGNED BY A LICENSED PROFESSIONAL BUILDING SYSTEMS MUST BE DESIGNED BY A LICENSED PROFESSIONAL INGUISED BY A LICENSED PROFESSIONAL ENGINEER AND SUBMITTED FOR APPROVALA FROR TO INSTALLATION. UNDERFRINING OF ADJACENT STRUCTURE MAY BE REQUISED IF COUNTAIN ON EXCAVATION SETTEMBERS BUILDING TO INSTALLATION. UNDERFRINING OF ADJACENT STRUCTURE MAY BE REQUISED IN A LICENSED PROFESSIONAL SETTEMBERS AND ADJACENT FOR WORK MAY BE REQUISED BY A LICENSED FROM BOTTON OWN FOR KEAR THE PROPERTY LIVE MUST BE PERFORMED IN A MANNER THAT DOES NOT UNDERMINE OR DAMAGE ADJACENT STRUCTURES MUST BE SOUT UNDERMINE OR DAMAGE ADJACENT STRUCTURES MUST BE SOUT WINDERFRINING OR SOIL STABLEZION AS NECESSARY.

 3. ADJACENT STRUCTURES MUST BE STRUCTURES MUST BE STRUCTURES WIS THE CALL STRUCTURES WIS THE CALL STRUCTURE SHOWS THE STRUCTURE SHOWS THE CALL STRUCTURE SHOWS THE CALL STRUCTURE SHOWS THE CALL STRUCTURE SHOWS THE CALL THE STRUCTURE SHOWS THE CALL THE SHOWS THE STRUCTURE OR STABILLTY.


 EXCAVATION SUPPORT SYSTEMS MUST BE DESIGNED TO ACCOUNT FOR TEMPORARY AND PERMANENT EARTH PRESSURES WITHOUT RELYING ON ADJACENT STRUCTURE FOR STABILLTY.

 CONTRACTOR SHALL BE SOLUCLY RESPONSIBLE FOR DAMAGE OR ADJACENT STRUCTURE SRESULTING FROM CONSTRUCTION ACTIVITY.

COLUMN FOOTING SCHEDULE							

MARK*	LENGTH	WIDTH	THICKNESS	TOP & BTM REINF.* EA. WAY U.N.O.	REMARKS
2F4.5	4' - 6"	4' - 6"	1' - 6"	(6)-#5	STD. ACI HOOK
16" Diameter					

GRADE BEAM SCHEDULE												
MARK	BEAM WIDTH	BEAM DEPTH	TOP REINF. CONT.	BOTTOM REINF. CONT.	TOP & BTM REINF. TRANSV.	REMARKS						
GR-1	2' - 0"	1' - 6"	(4).#6	(4).#6	#5 @10"	STD ACLHOOK						

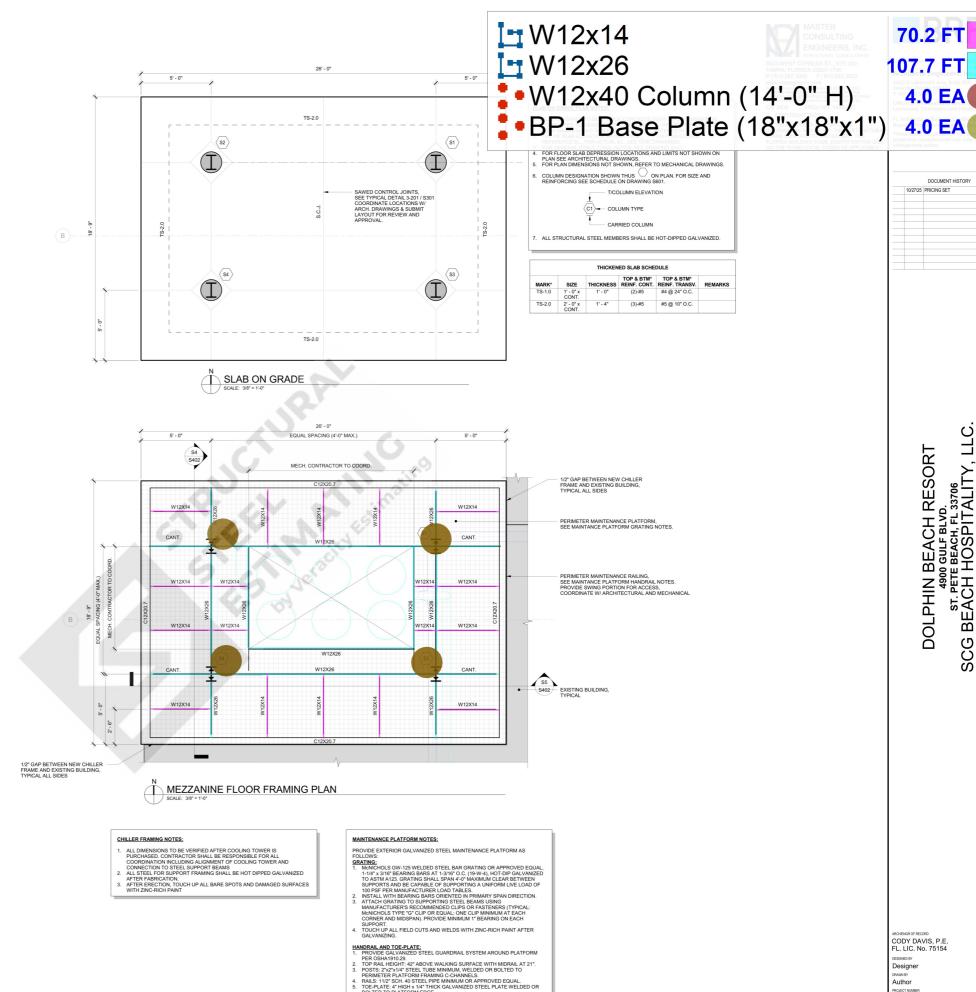

Designer DRAWN BY Author 10/21/25

> CHILLER SUPPORT DETAILS

70.2 FT

107.7 FT

10/27/25 PRICING SET

DOLPHIN BEACH RESORT
4900 GULF BLVD.
ST. PETE BEACH, FL 33706
SCG BEACH HOSPITALITY, LLC.

S204

CODY DAVIS, P.E FL. LIC. No. 75154

D1 CONCRETE ENCASEMENT DETAIL
(\$402) SCALE: 1 1/2" = 1'-0"

2L4x4x1/4 CONSULTING ENGINEERS, INC.

36.7 FT

TAMPA, FLORIDA 33607-1735
P | 813.287-3600 F | 813.287-3622
www.mcengineers.com
History and Very and V

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INFORMATION AND BELIEF, THESE STRUCTURA
PLANS CONFORM TO AND SATISFY, THE
FLORIDA BUILDING CODE, EIGHTH EDITION 2023

Architects Engineers, Inc. 2420 S Lakemont Ave, Suite 300 Orlando, Florida 32814 T 407-896-9301

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DOCUMENT HISTORY

10/27/25 PRICING SET

DOLPHIN BEACH RESORT
4900 GULF BLVD.
ST. PETE BEACH, FL 33706
SCG BEACH HOSPITALITY, LLC.

D

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hin Resort Hotel Reno -

D1 TYP. S4 SECTION 4 S402 SCALE: 1/2" = 1'-0" S5 SECTION 5 S402 SCALE: 1/2" = 1'-0"

ARCHENGR OF RECORD
CODY DAVIS, P.E.
FL. LIC. No. 75154

DESIGNED BY
Designer
DRAWN BY
Author
PROJECT NUMBER
C09632.001

C09632.001 DATE 10/21/25

SECTION AND DETAILS

\$402

2 3 4 5