

Building Data Summary												
Project ID:	Deming Park Pool Renovation											
Location:	500 S Fruitridge AVE. Terre Haute, IN 47803											
Scope of Work:	Misc. Metal											
Date:												

Item #	Ref. Sheet #	Item Description	Unit	Quantity	Wastage	Quantity w/ Wastage	Unit Material Cost	Total Material Cost	Unit Manhour	Hourly Wage	Unit Labor Cost	Total Labor Cost	Sub Cost	Total Trade Cost	
<b>DIVISION 01 GENERAL REQUIREMENTS</b>															
1		Supervision and Coordination	LS	1	0%	1	\$ -	\$ -	0.000	\$ -	\$ -	\$ -	\$ 6,500.00		
2		Submittals and Shop drawings	LS	1	0%	1	\$ -	\$ -	0.000	\$ -	\$ -	\$ -	\$ 3,500.00		
3		Final Cleaning	LS	1	0%	1	\$ -	\$ -	0.000	\$ -	\$ -	\$ -	\$ 1,200.00		
4		Mobilization Costs	LS	1	0%	1	\$ -	\$ -	0.000	\$ -	\$ -	\$ -	\$ 7,000.00		
5		Temporary Control & Facilities	LS	1	0%	1	\$ -	\$ -	0.000	\$ -	\$ -	\$ -	\$ 1,500.00		
6		Temporary Showring To Support The Existing Structure	LS	1	0%	1	\$ -	\$ -	0.000	\$ -	\$ -	\$ -	\$ 7,500.00		
		<b>Subtotal (General Requirements)</b>												<b>\$ 27,200</b>	
<b>DIVISION 02 - SITE WORK/ EXISTING CONDITIONS</b>															
		<b>Demolition</b>													
7	S201	Remove Chemical Roof Framing And Roof Deck	SF	373	0%	373	\$ -	\$ -	0.120	\$ 40.00	\$ 4.80	\$ 1,790.40	\$ 1,790.40		
8		Remove Existing Roof Decking And Purlins	SF	2040	0%	2040	\$ -	\$ -	0.085	\$ 40.00	\$ 3.40	\$ 6,936.00	\$ 6,936.00		
9		Remove Existing Column	EA	6	0%	6	\$ -	\$ -	3.500	\$ 40.00	\$ 140.00	\$ 840.00	\$ 840.00		
		<b>Subtotal (Site Work/ Existing Conditions)</b>											<b>\$ 9,566</b>	<b>\$ 9,566</b>	
<b>DIVISION 04- Metal</b>															
		<b>Base Bid</b>													
		<b>Angles</b>													
10		L6x4x3/8	LF	15	5%	16	\$ 12.00	\$ 189.00	0.250	\$ 40.00	\$ 10.00	\$ 157.50	\$ 346.50		
11		(2) L4x4x1/4x3" Long Angle Clips At Each Wind Column	EA	2	0%	2	\$ 35.00	\$ 70.00	0.750	\$ 40.00	\$ 30.00	\$ 60.00	\$ 130.00		
12		(4) L6x4x1/4 Angle Spanning Length of Bent Plate	LF	34	5%	36	\$ 10.00	\$ 357.00	0.200	\$ 40.00	\$ 8.00	\$ 285.60	\$ 642.60		
13		L2 1/2 x 2 1/2 x 3/16 Coordinate Height W screen Termination Weld To Bent Plate 2 Lines Of 3/16" Fillet Weld At A1-6 Pattern	EA	2	0%	2	\$ 45.00	\$ 90.00	1.500	\$ 40.00	\$ 60.00	\$ 120.00	\$ 210.00		
		<b>Column</b>													
14		Hss4x4x3/16 HSS Column (6 EA , 5'-4" H)	LBs	345	5%	362	\$ 1.85	\$ 670.16	0.020	\$ 40.00	\$ 0.80	\$ 289.80	\$ 959.96		
		-Steel Angle Clips At Base Oh HSS Column Both Side w 1/2" Dia Hit Z And Hit-Z-R Anchor Rods -Backer Bars 4 Side													
		<b>Note: Column Detail Is Assumed Not Given By Plan &amp; Section</b>													
		<b>Panel &amp; Purlins</b>													
15		Replace Roof Decking And Purlins (14 Gauge 4"x 3.5' Zee Purlins) At 5'-0" O.C	SF	2040	5%	2142	\$ 8.50	\$ 18,207.00	0.120	\$ 40.00	\$ 4.80	\$ 10,281.60	\$ 28,488.60		
		<b>Gutter</b>													
16		Aluminum Gutter (Detail Not Given)	LF	146	5%	153	\$ 18.00	\$ 2,759.40	0.150	\$ 40.00	\$ 6.00	\$ 919.80	\$ 3,679.20		
		<b>Flashing</b>													
17		Metal Flashing (Detail Not Given)	LF	146	5%	153	\$ 10.00	\$ 1,533.00	0.100	\$ 40.00	\$ 4.00	\$ 613.20	\$ 2,146.20		
		<b>Downspout</b>													
18		Downspout (9' H , 4 EA) Assumed	LF	36	5%	38	\$ 14.00	\$ 529.20	0.200	\$ 40.00	\$ 8.00	\$ 302.40	\$ 831.60		
		<b>Doors</b>													
19		(3'-0" x 2 1/2" Hollow Metal Door W Frame & Hardware	EA	4	0%	4	\$ 1,350.00	\$ 5,400.00	2.500	\$ 40.00	\$ 100.00	\$ 400.00	\$ 5,800.00		
20		(5'-0" x 2 1/2" Hollow Metal Door W Frame & Hardware	EA	2	0%	2	\$ 1,650.00	\$ 3,300.00	3.500	\$ 40.00	\$ 140.00	\$ 280.00	\$ 3,580.00		
21		(4'-0" x 2 1/2" Hollow Metal Door W Frame & Hardware	EA	1	0%	1	\$ 1,500.00	\$ 1,500.00	4.500	\$ 40.00	\$ 180.00	\$ 180.00	\$ 1,680.00		
22		(15'-2" W x 7'-7" H) Corrugated/Perforated Metal panel W Frame & Hardware	EA	2	0%	2	\$ 3,800.00	\$ 7,600.00	8.500	\$ 40.00	\$ 340.00	\$ 680.00	\$ 8,280.00		
		<b>Alternate No 4</b>													
		<b>Angles</b>													
23		L4x4x1/4 Edge Angle	LF	22	5%	23	\$ 9.00	\$ 207.90	0.180	\$ 40.00	\$ 7.20	\$ 166.32	\$ 374.22		
24		L4x4x1/2 ledger Angle Fasten To Existing Wall @ 16" OC - Using SS 1/2" Dia Hilti Has Rods w Hilti Hit HY 270 Adhesive System (4" Embed)	LF	31	5%	33	\$ 32.00	\$ 1,041.60	0.450	\$ 40.00	\$ 18.00	\$ 585.90	\$ 1,627.50		
25		L6x4x1/2x6" Long Bearing Angle Weld To Sloped Angle Anchor Into Wall BB W 3/4" Dia Cast In Bolt (6" Embed)	EA	2	0%	2	\$ 185.00	\$ 370.00	1.500	\$ 40.00	\$ 60.00	\$ 120.00	\$ 490.00		
26		L6x4x1/4 ledger Angle Fasten To Bond Beam @ 16" OC - Using SS 1/2" Dia Hilti Has Rods w Hilti Hit HY 270 Adhesive System (4" Embed)	LF	31	5%	33	\$ 30.00	\$ 976.50	0.420	\$ 40.00	\$ 16.80	\$ 546.84	\$ 1,523.34		
		<b>Panel &amp; Purlins</b>													
27	S201 To A601	Corrugated Metal Panel - 14 Gauge 4" x 2.5" Zee Purlins At 4'-6" OC	SF	360	5%	378	\$ 9.25	\$ 3,496.50	0.140	\$ 40.00	\$ 5.60	\$ 2,116.80	\$ 5,613.30		
28		<b>Gutter</b>													
29		Aluminum Gutter (Detail Not Given)	LF	54	5%	57	\$ 18.00	\$ 1,020.60	0.150	\$ 40.00	\$ 6.00	\$ 340.20	\$ 1,360.80		
		<b>Downspout</b>													
30		Downspout (9' H , 4 EA) Assumed	LF	36	5%	38	\$ 14.00	\$ 529.20	0.200	\$ 40.00	\$ 8.00	\$ 302.40	\$ 831.60		
		<b>Alternate No 5</b>													
		<b>Post</b>													
31		HSS4x4x1/4 Fence Post ( HDG ) (8'-3" H - 74 EA)	LF	592	5%	622	\$ 85.00	\$ 52,836.00	0.550	\$ 40.00	\$ 22.00	\$ 13,675.20	\$ 66,511.20		
		<b>Fence</b>													
32		Delegated Design Fence Panel ( Detail Not Given ) (8' H)	LF	166	5%	174	\$ 120.00	\$ 20,916.00	0.350	\$ 40.00	\$ 14.00	\$ 2,440.20	\$ 23,356.20		
		<b>Alternate No 6</b>													
		<b>Beam</b>													
33		Double L3x3x1/4 Tension Tie	LF	133	5%	140	\$ 20.00	\$ 2,793.00	0.300	\$ 40.00	\$ 12.00	\$ 1,675.80	\$ 4,468.80		
		Tension Tie Connection For Both Side													
34		W4x13 x 2 1/2" Long Bearing Beam Weld To Gabled Beam (2 EA)	LBs	56	5%	59	\$ 2.75	\$ 161.70	0.035	\$ 40.00	\$ 1.40	\$ 82.32	\$ 244.02		
		W18x18 (157 LF)	LBs	2826	5%	2967	\$ 3.10	\$ 9,198.63	0.040	\$ 40.00	\$ 1.60	\$ 4,747.68	\$ 13,946.31		
		Dia A325 Thru Bolts (6 EA)													
35		<b>Plate</b>													
36		(1/2") Thick Gusset Plate	EA	10	0%	10	\$ 90.00	\$ 900.00	1.500	\$ 40.00	\$ 60.00	\$ 600.00	\$ 1,500.00		
37		(8"x8") Steel Shim Plate For Uniform Bearing	EA	2	0%	2	\$ 20.00	\$ 40.00	0.200	\$ 40.00	\$ 8.00	\$ 16.00	\$ 56.00		
		(1"-0" x 6" x 3/4" ) Thick Cap Plate W 94) 3/4" Dia A325 Thru Bolts	EA	10	0%	10	\$ 260.00	\$ 2,600.00	1.800	\$ 40.00	\$ 72.00	\$ 720.00	\$ 3,320.00		
		<b>Angles</b>													
38		(2) L4 x 4x1/4 x 1'-8" Long Angles	EA	2	0%	2	\$ 240.00	\$ 480.00	1.500	\$ 40.00	\$ 60.00	\$ 120.00	\$ 600.00		
		(-4) SS 1/2" Dia Hilti Has Rods With Hilti Hit Hy 270													
39		L4x4x1/4 ledger Angle Fasten To Bond Beam @ 16" OC - Using SS 1/2" Dia Hilti Has Rods w Hilti Hit HY 270 Adhesive System (4" Embed)	LF	138	5%	145	\$ 55.00	\$ 7,969.50	0.700	\$ 40.00	\$ 28.00	\$ 4,057.20	\$ 12,026.70		
		-Remove Flange And Add (6" W x 1/2" Thick Steel ) Plates At Beam Taper CJP Weld At taper plate													
		<b>Column &amp; Pier</b>													
40		Helical Pier ( Detail Not Given )	EA	36	0%	36	\$ 1,650.00	\$ 59,400.00	6.000	\$ 40.00	\$ 240.00	\$ 240.00	\$ 8,640.00	\$ 68,040.00	
41		Hss4x4x3/16 Wind Column (4 EA , 8'-8" H)	LBs	374.4	5%	393	\$ 2.20	\$ 864.86	0.030	\$ 40.00	\$ 1.20	\$ 471.74	\$ 1,336.61		
		-Base Plate W (4) 1/2" Dia SS Hilti Has Rods W Hilti Hit Hy 200 Adhesive System (Embed 6"													
42		HSS55x5x3/8 (10 EA , 8'-8" H)	LBs	2194	5%	2304	\$ 2.35	\$ 5,413.70	0.032	\$ 40.00	\$ 1.28	\$ 2,948.74	\$ 8,362.43		
		-Base Plate W (4) 1/2" Dia SS Hilti Has Rods W Hilti Hit Hy 200 Adhesive System (Embed 6"													
		<b>Panel &amp; Purlins</b>													
43		Corrugated Metal Panel	SF	1193	5%	1253	\$ 9.25	\$ 11,587.01	0.140	\$ 40.00	\$ 5.60	\$ 7,014.84	\$ 18,601.85		
		14 Gauge 4x1.25" Zee purlins At 4'-0" O.C													
		<b>Gutter</b>													
44		Aluminum Gutter ( Detail Not Given )	LF	84	5%	88	\$ 18.00	\$ 1,587.60	0.150	\$ 40.00	\$ 6.00	\$ 529.20	\$ 2,116.80		
		<b>Flashing</b>													
45		Metal Flashing ( Detail Not Given )	LF	84	5%	88	\$ 10.00	\$ 882.00	0.100	\$ 40.00					

**DEMING PARK  
POOL  
RENOVATION**  
500 S Fruitridge Ave.  
Terre Haute, IN 47803

**EXISTING FOUNDATION REPAIRS AND SELECTIVE DEMO PLAN NOTES**

○ INDICATES NOTE REFERENCED IN PLAN

- SEE GENERAL STRUCTURAL NOTES AND TYPICAL REPAIR PROCEDURES (S102) FOR ADDITIONAL INFORMATION.
- ALL COLUMNS WITHIN THE SCOPE OF THIS PROJECT ARE TO BE CLEANED AND PAINTED (CP). IF DURING THIS PROCEDURE THE CONTRACTOR FINDS SUBSTANTIAL SECTION LOSS (I.E., HOLES IN THE TUBE) OR A DETERIORATED ANCHOR RODS OR BASE PLATE, THEY SHALL NOTIFY THE ENGINEER.
- REFER TO ARCH. DWGS. FOR INTERIOR PARTITION WALL AND FLOOR SLAB DEMO EXTENTS.

**TEMPORARY BRACING AND SHORING NOTES**

○ INDICATES NOTE REFERENCED IN PLAN

**A** CONTRACTOR SHALL PROVIDE TEMPORARY LATERAL BRACING AS REQUIRED TO STABILIZE EXISTING MASONRY WALLS DURING SLAB-ON-GRADE AND ROOF DECK REPLACEMENT WORK. BRACING SHALL REMAIN IN PLACE UNTIL BOTH THE NEW SLAB AND ROOF DECK HAVE BEEN FULLY INSTALLED AND ARE CAPABLE OF PROVIDING LATERAL SUPPORT TO THE WALLS EQUIVALENT TO THEIR ORIGINAL CONDITION.

**B** CONTRACTOR SHALL PROVIDE TEMPORARY SHORING OF ROOF FRAMING AT COLUMN REPLACEMENT LOCATIONS. SEE PLAN FOR APPLICABLE LOCATIONS. SEE "COLUMN REPLACEMENT" PROCEDURE SHEET S102 FOR ADDITIONAL REQUIREMENTS.

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SHEET ISSUE  
1 CONSTRUCTION DOCUMENTS 10/10/25

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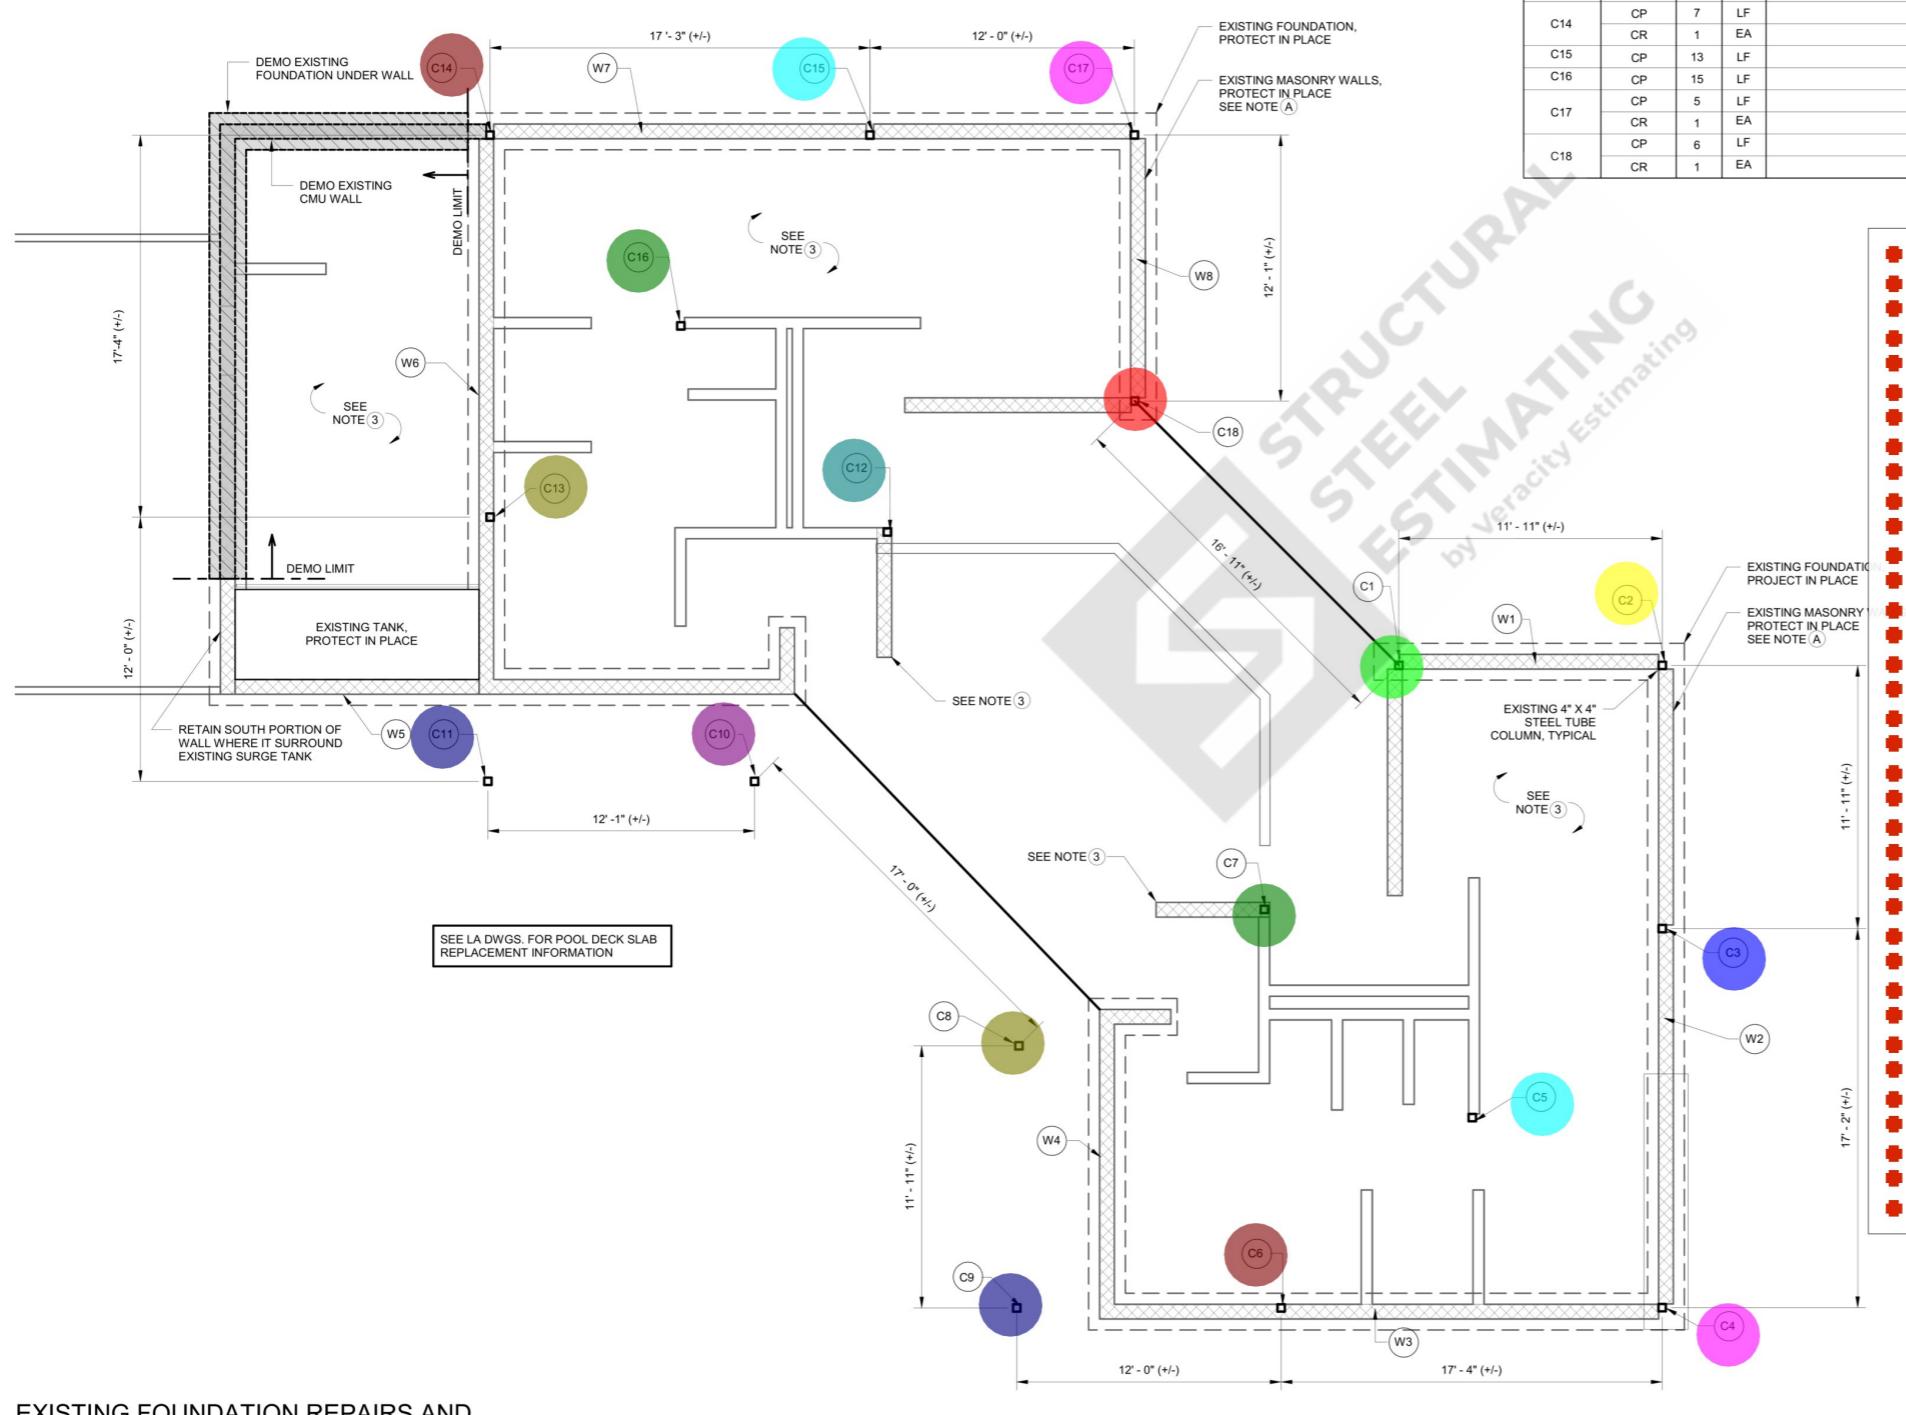
PROJECT NO. 25-153

SHEET TITLE  
EXISTING  
FOUNDATION  
REPAIRS AND  
SELECTIVE DEMO  
SHEET NUMBER  
S-201

WALL REPAIR SCHEDULE				
WALL	REPAIR	QTY	UNIT	NOTES
W1	CMU-R	20	SF	
W3	TP	150	SF	
W4	TP	100	SF	
W5	TP	100	SF	
W6	CMU-R	20	SF	
W7	TP	150	SF	
W8	CMU-R	20	SF	

REPAIR AND UNIT LEGEND			
REPAIR	UNIT	REFERENCE	
CLEAN AND PAINT	CP	LF	LINEAR FEET
CMU BLOCK REPLACEMENT	CMU-R	SF	SQUARE FEET
MASONRY TUCKPOINTING	TP	SF	SQUARE FEET
COLUMN CLIP ANGLE REPAIR	CCA	EA	EACH
COLUMN REPLACEMENT	CR	EA	EACH

COLUMN REPAIR SCHEDULE				
COLUMN	REPAIR	QTY	UNIT	NOTES
C1	CP	6	LF	
	CR	1	EA	
C2	CP	5	LF	
	CR	1	EA	
C3	CP	11	LF	
	CR	7	LF	
C4	CP	1	EA	
	CR	13	LF	
C5	CCA	2	EA	
	CP	12	LF	
C6	CP	13	LF	
	CCA	1	EA	
C7	CP	11	LF	
	CCA	2	EA	
C8	CP	11	LF	
	CCA	2	EA	
C9	CP	11	LF	
	CCA	2	EA	
C10	CP	11	LF	
	CCA	2	EA	
C11	CP	11	LF	
	CCA	2	EA	
C12	CP	13	LF	
	CCA	12	LF	
C13	CP	7	LF	
	CCA	1	EA	
C14	CP	13	LF	
	CCA	15	LF	
C15	CP	5	LF	
	CCA	1	EA	
C16	CP	6	LF	
	CCA	1	EA	
C17	CP	1	EA	



C17	1.0 EA	●
C15	1.0 EA	●
C14	1.0 EA	●
C16	1.0 EA	●
C13	1.0 EA	●
C12	1.0 EA	●
C11	1.0 EA	●
C10	1.0 EA	●
C12	1.0 EA	●
C18	1.0 EA	●
C1	1.0 EA	●
C2	1.0 EA	●
C3	1.0 EA	●
C4	1.0 EA	●
C5	1.0 EA	●
C6	1.0 EA	●
C7	1.0 EA	●
C8	1.0 EA	●
C9	1.0 EA	●

PROJECT NO. 25-153  
SHEET TITLE EXISTING FOUNDATION REPAIRS AND SELECTIVE DEMO  
SHEET NUMBER S-201

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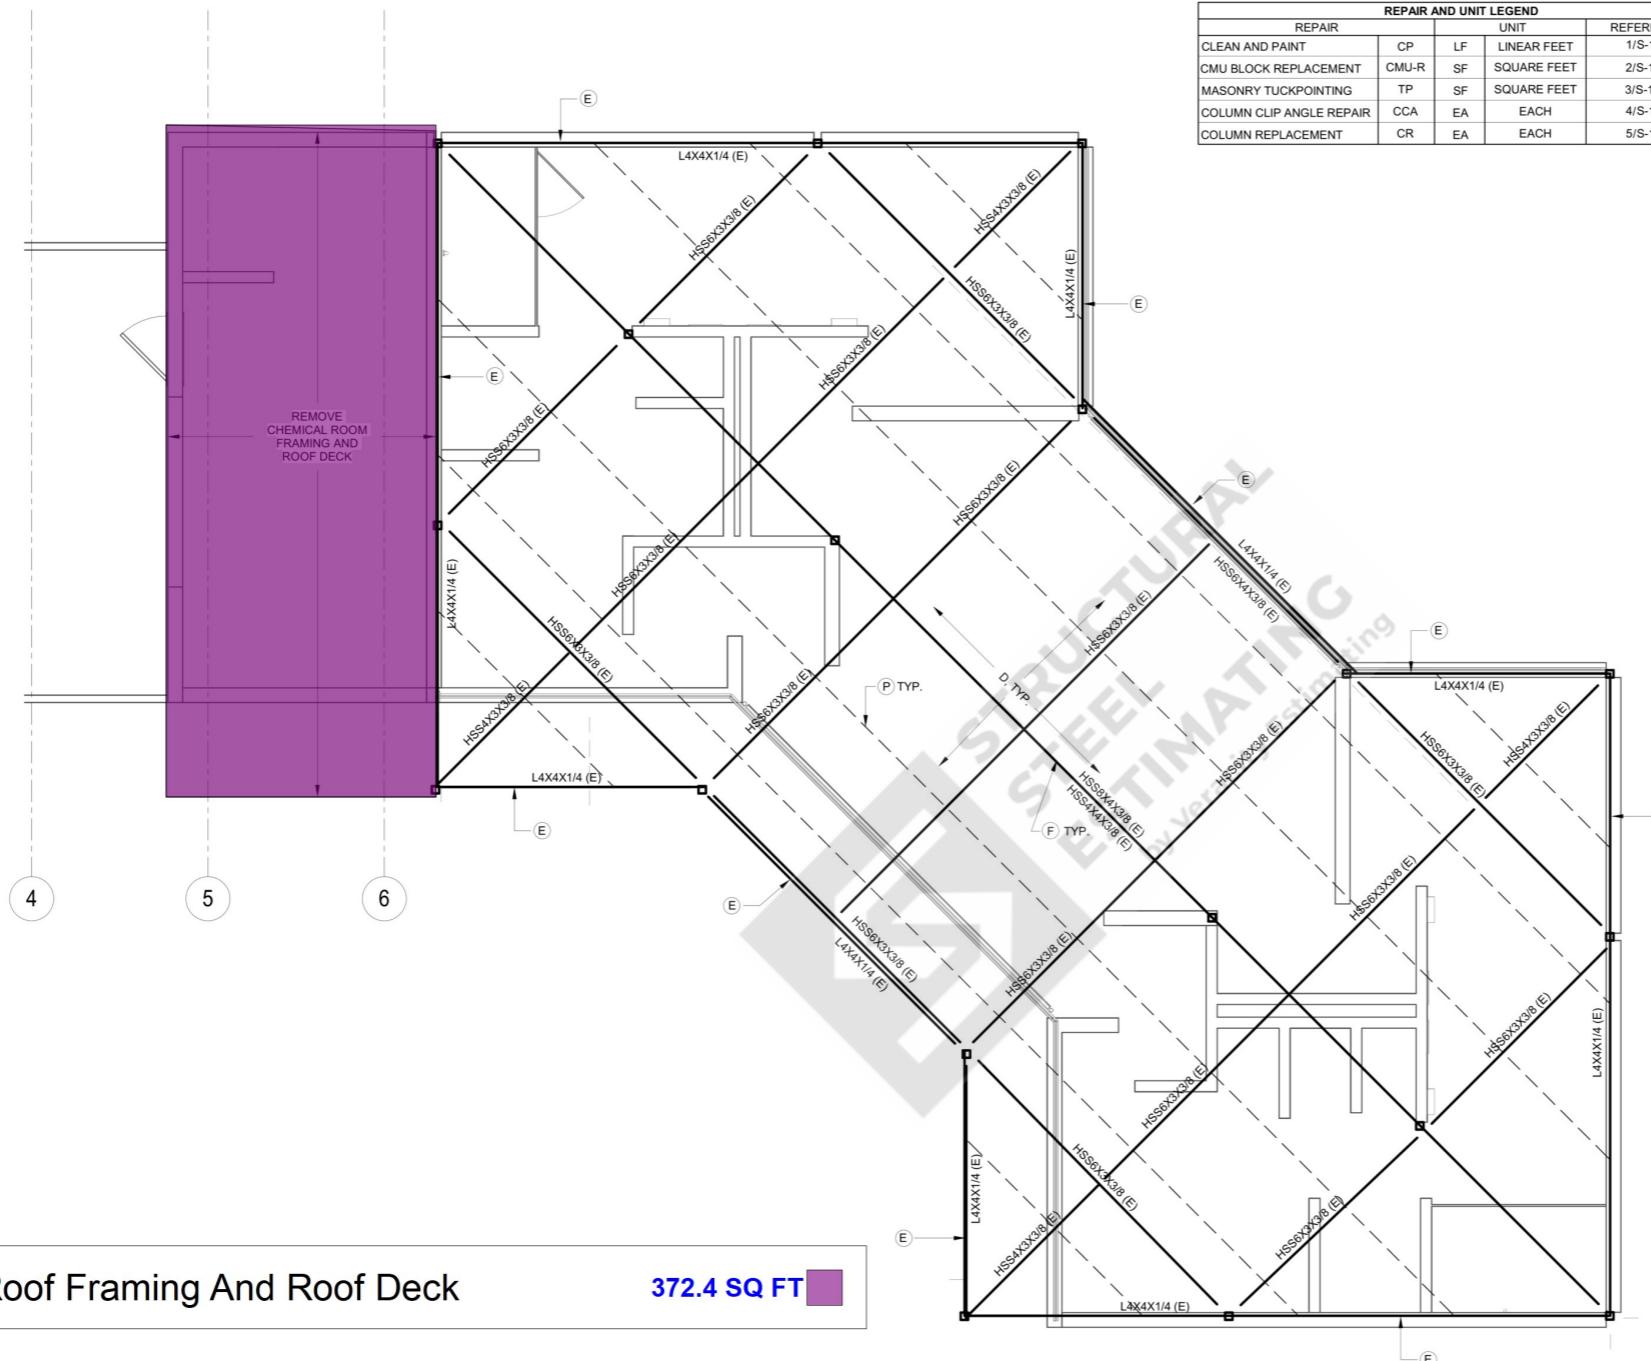
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PROJECT NO. 25-153

SHEET TITLE EXISTING ROOF  
FRAMING REPAIRS  
AND SELECTIVE  
DEMO

SHEET NUMBER S-202



ROOF FRAMING REPAIR SCHEDULE						
CALLOUT	MEMBER	REPAIR	QTY	UNIT	NOTES	REFERENCE
P	PURLIN	-	-	-	REPLACE	S204
F	FRAMING	CP	450	LF	CLEAN AND PAINT ALL SIDES OF TUBE FRAMING	S102
D	DECK	-	-	-	REPLACE	S204
E	EDGE	CP	200	LF	CLEAN AND PAINT ALL SIDES OF ANGLE	S102

EXISTING ROOF FRAMING REPAIR PLAN NOTES  
○ INDICATES NOTE REFERENCED IN PLAN  
1. SEE GENERAL STRUCTURAL NOTES AND TYPICAL REPAIR  
PROCEDURES (S102) FOR ADDITIONAL INFORMATION.



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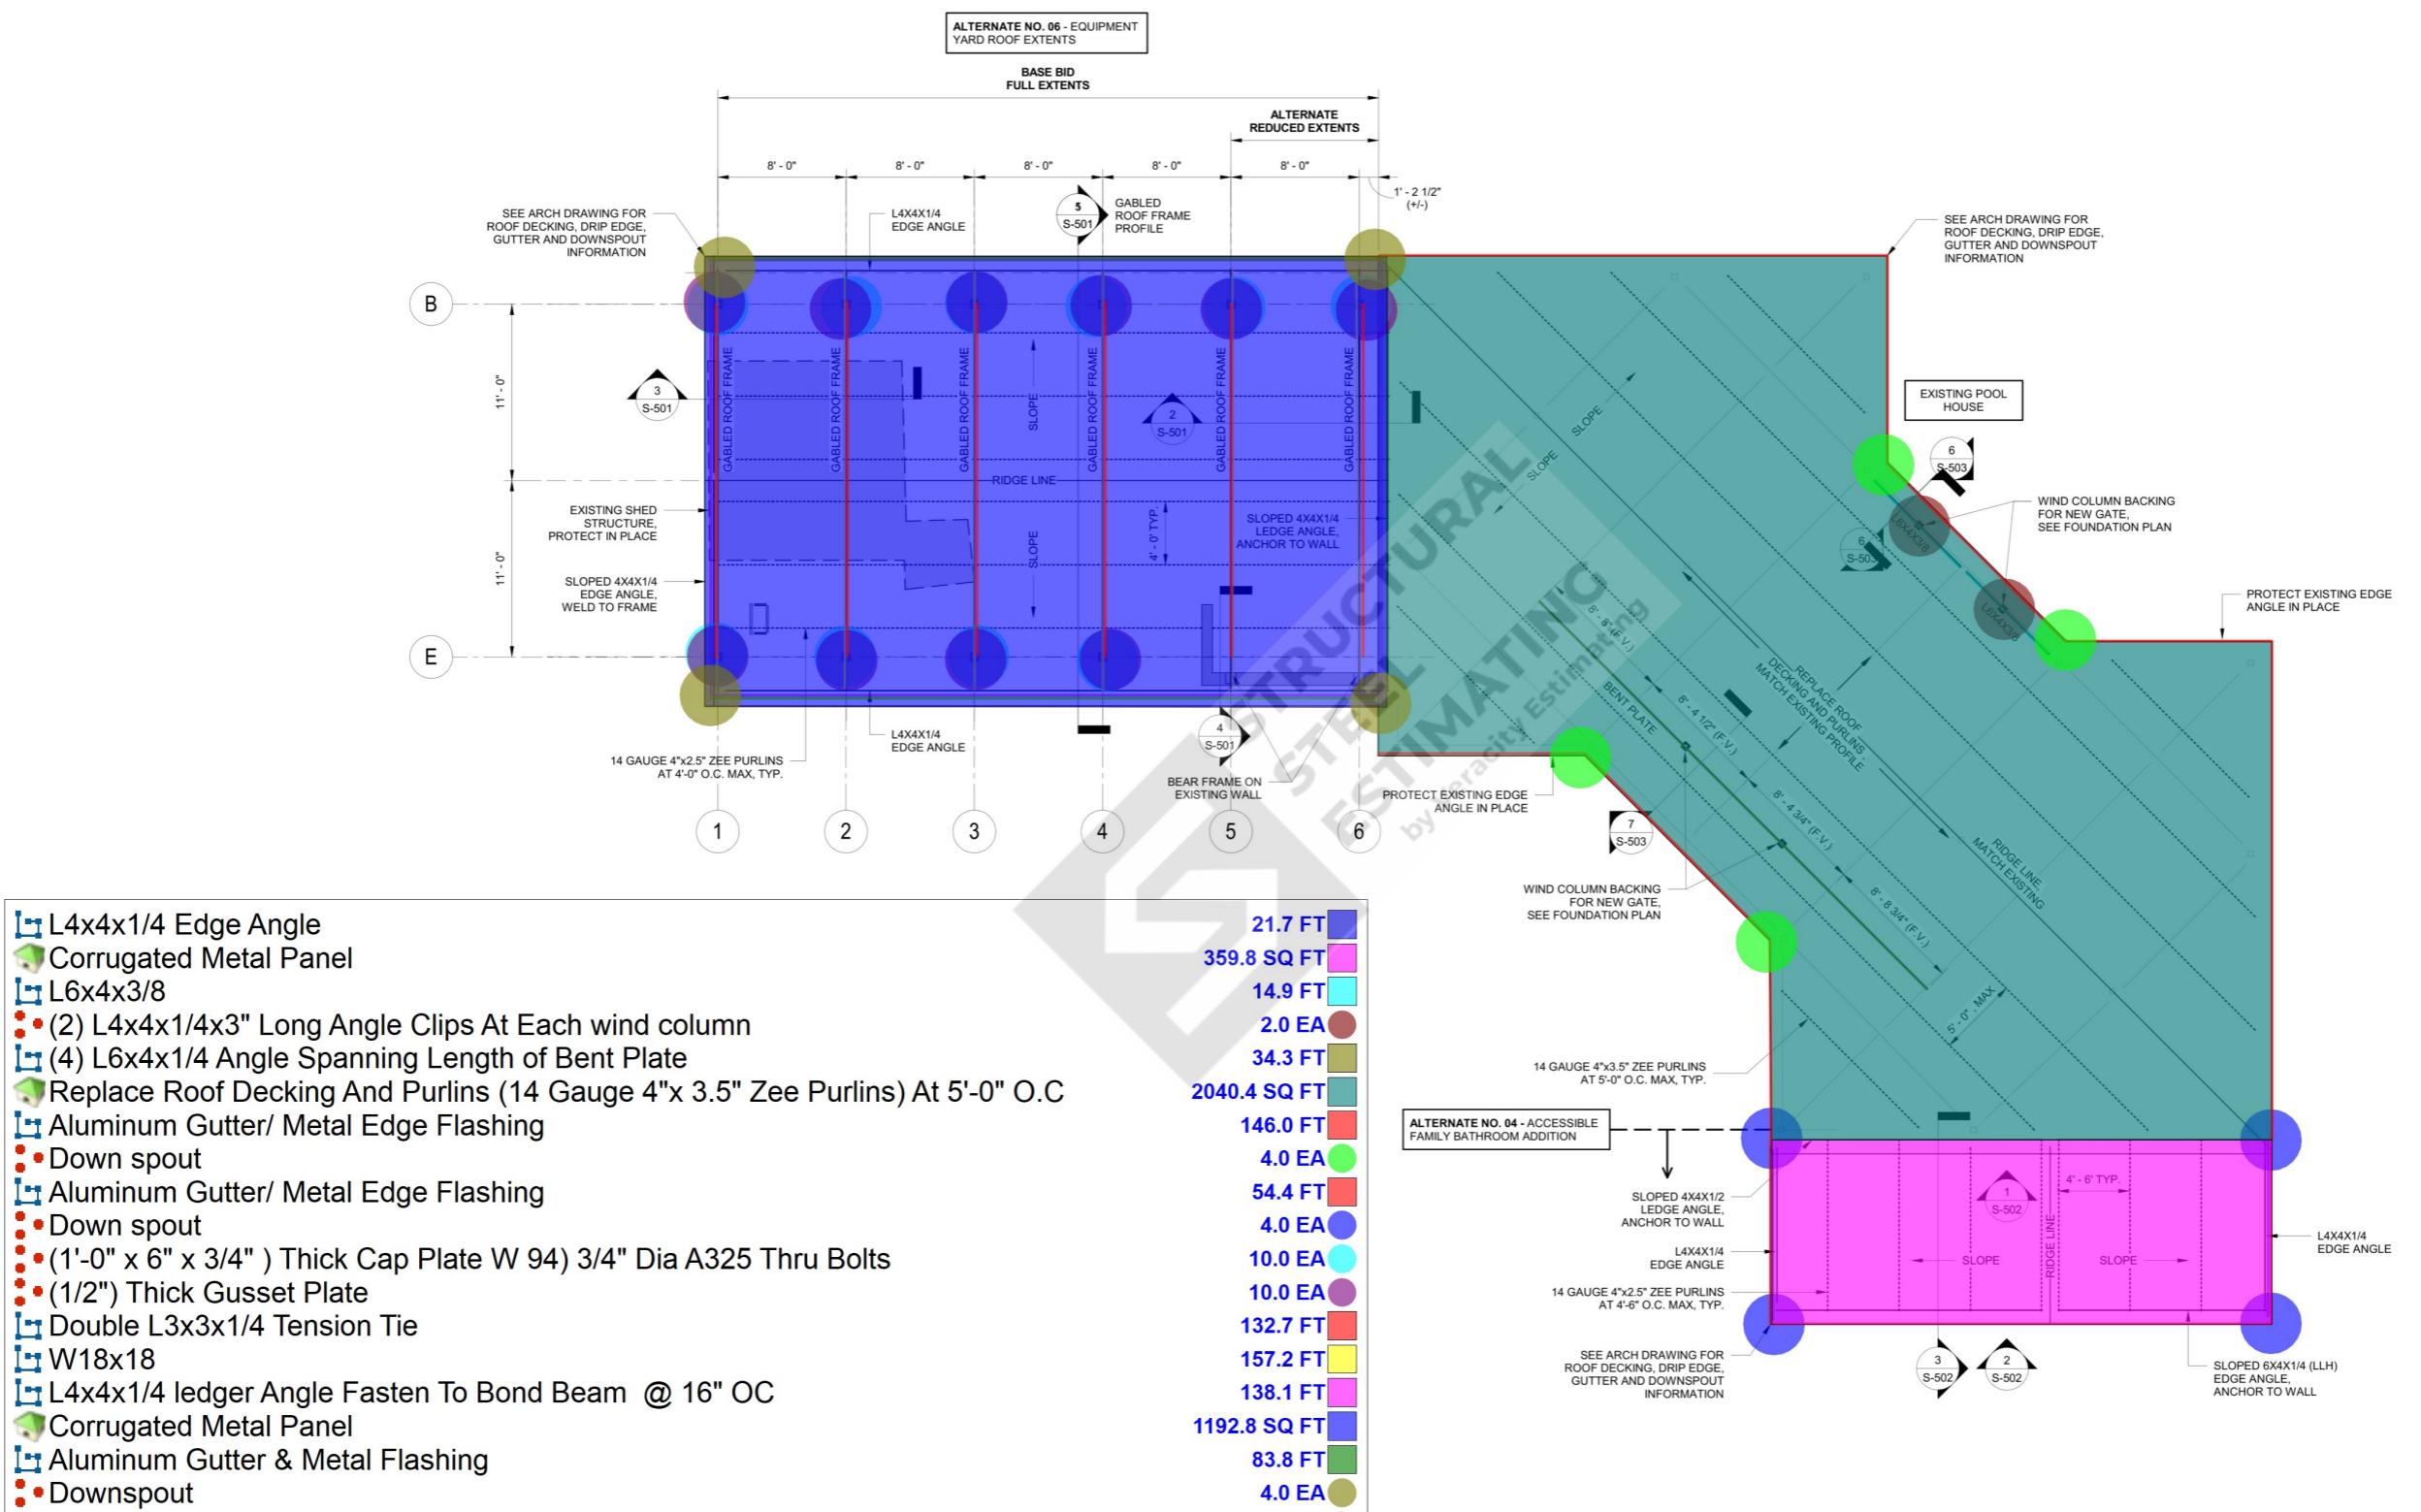
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PROJECT NO. 25-153  
HEET TITLE NEW ROOF FRAMING  
PLAN

SET NUMBER



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**SEAL / DATE**  
NATHAN DANIEL BALTZ  
REGISTERED  
No. PE180033  
STATE OF  
INDIANA  
Nathan D. Baltz  
10/10/25

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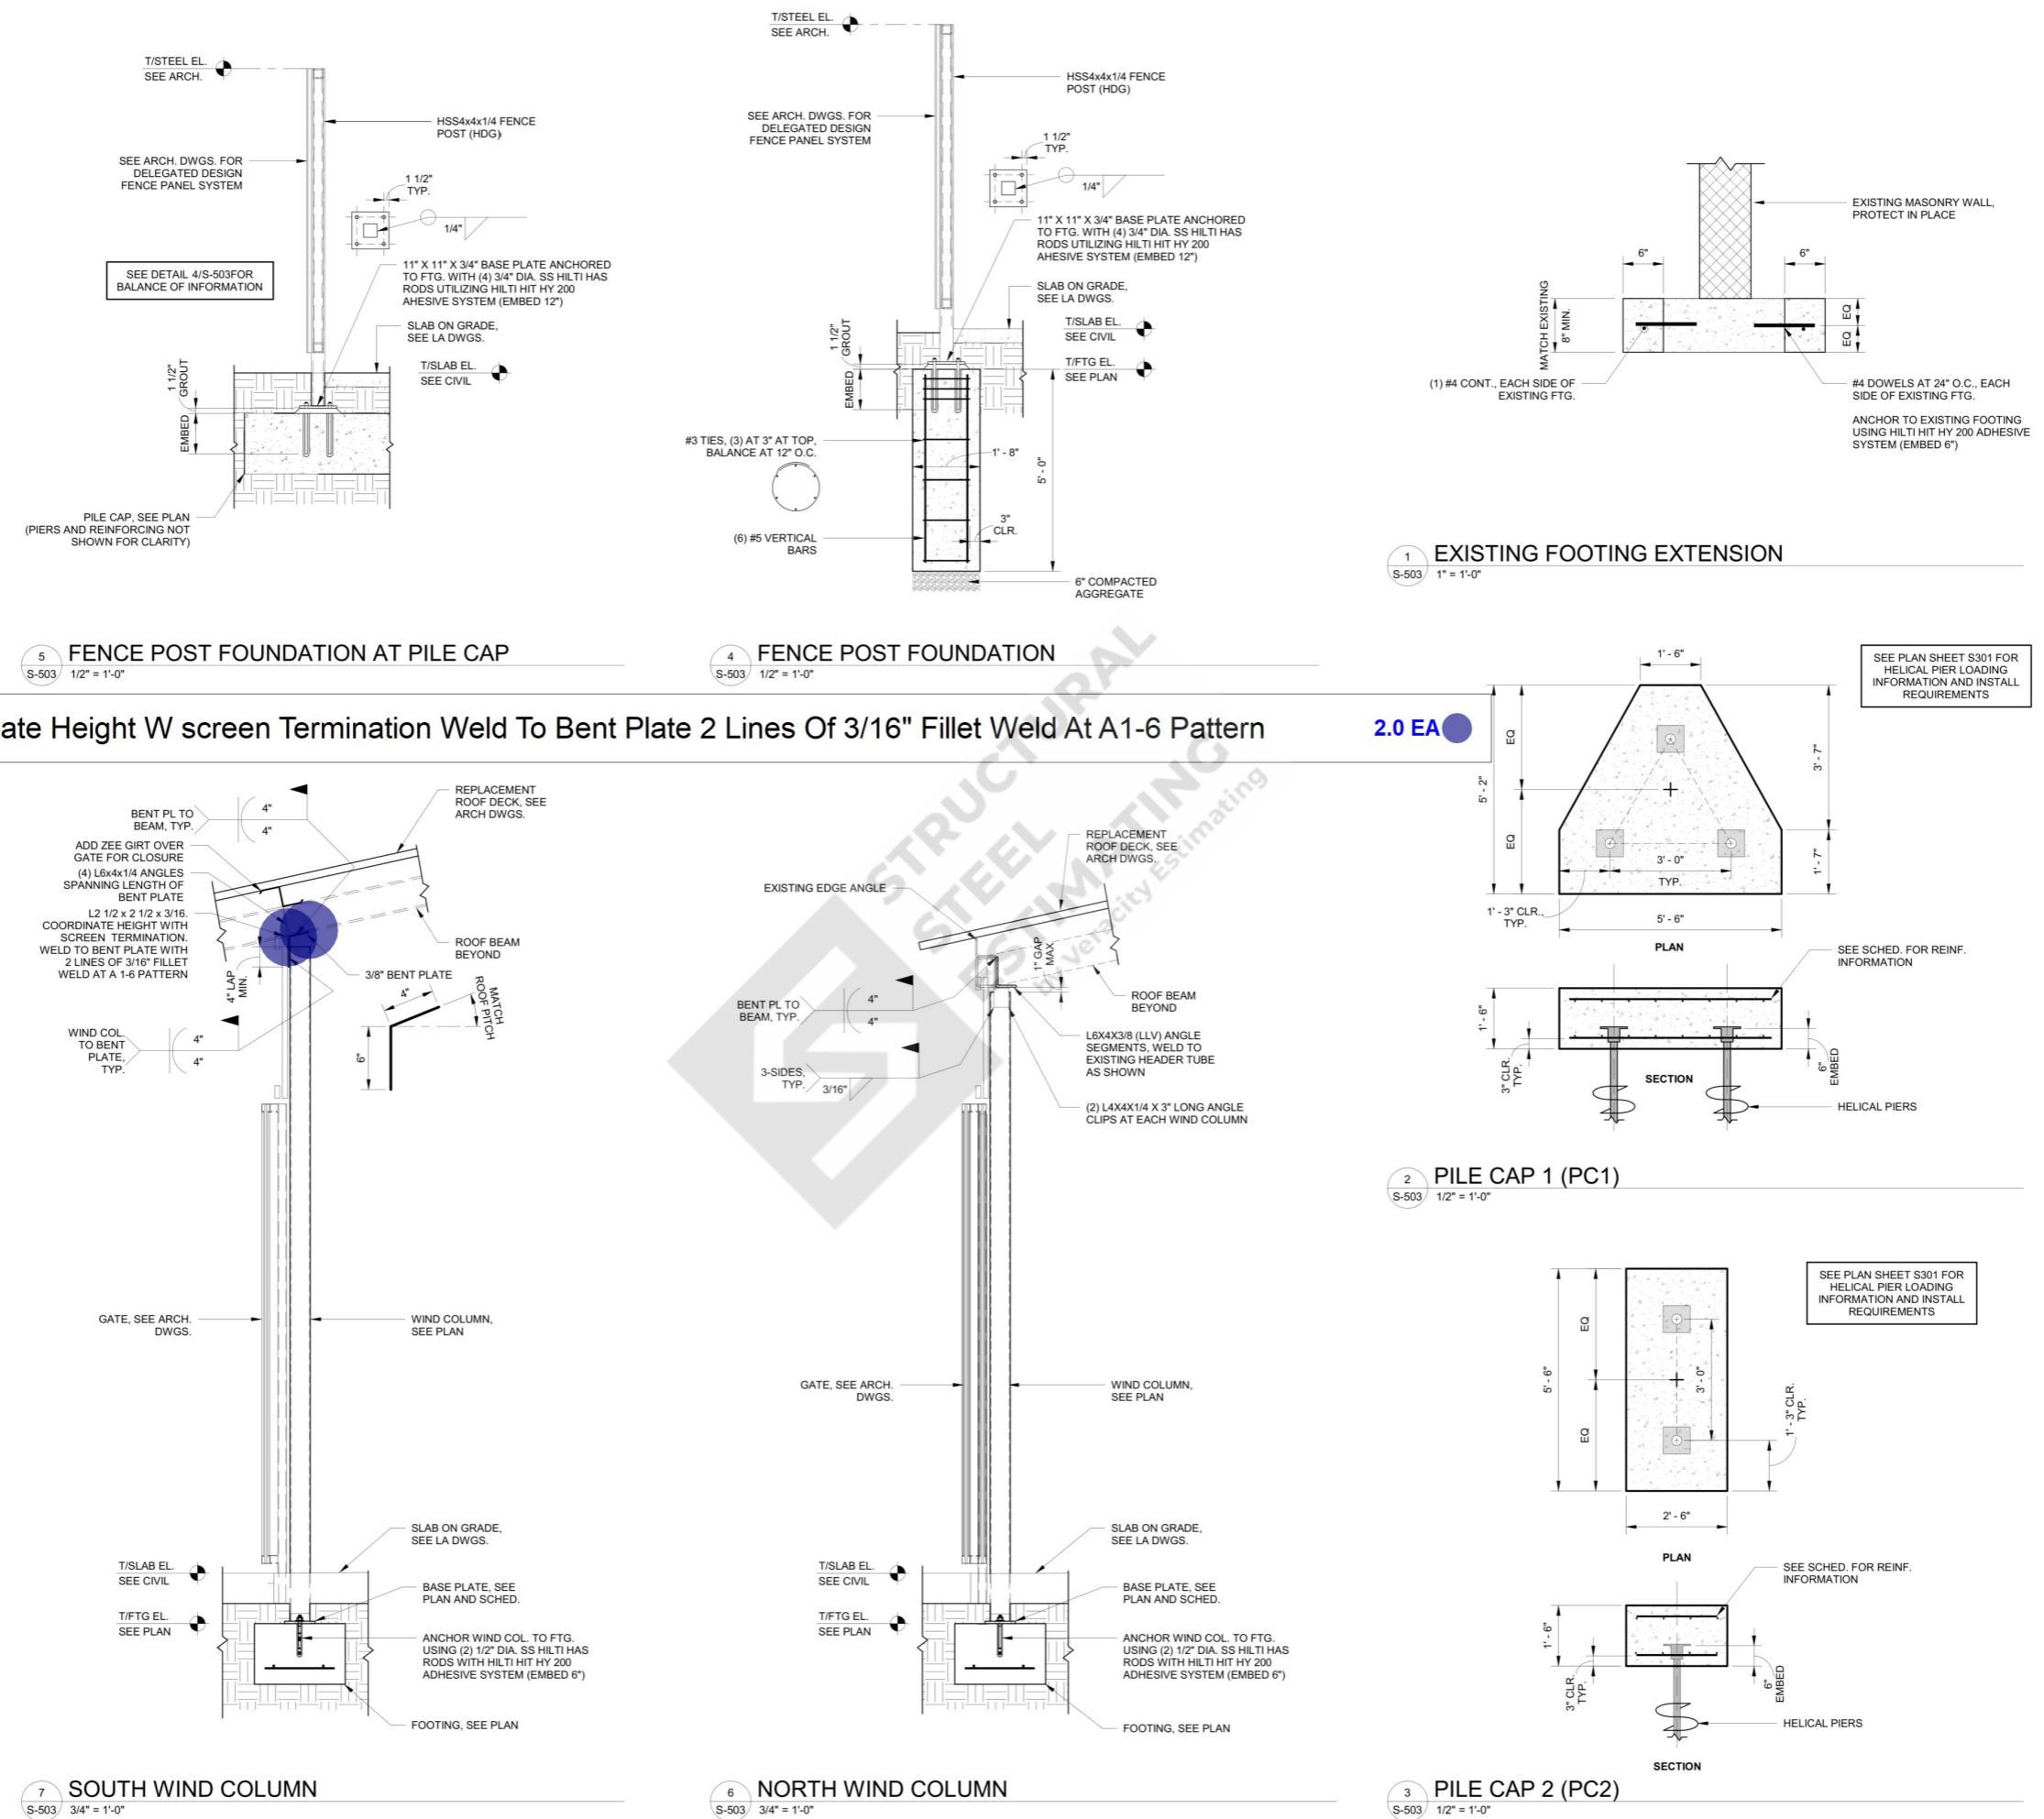
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PROJECT NO.

25-153  
**SECTIONS AND  
DETAILS**

SHEET NUMBER  
**S-503**



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SEAL | DATE  
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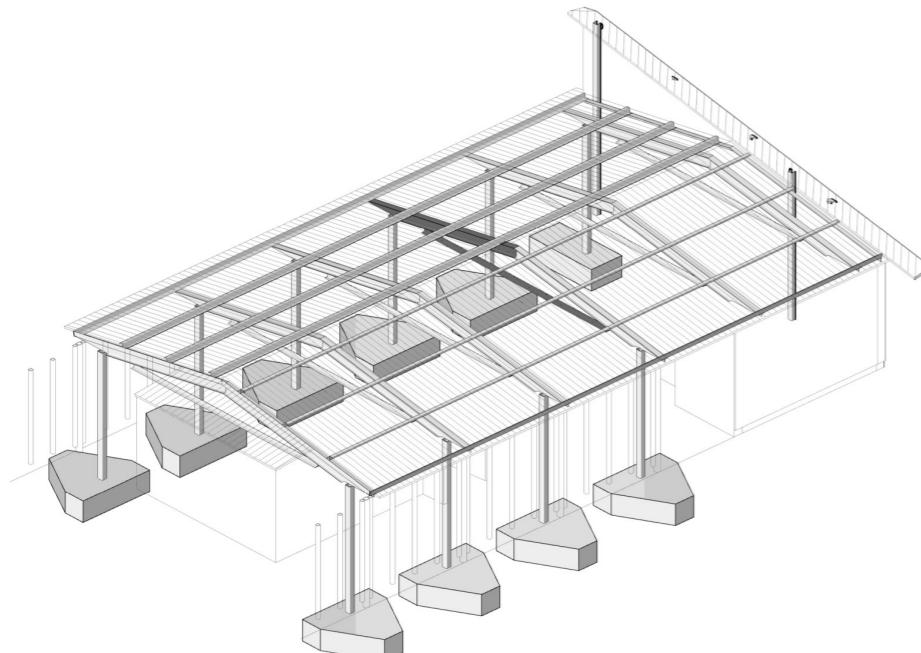
SHEET ISSUE  
1 CONSTRUCTION DOCUMENTS 10/10/25

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**RATIO**


PROJECT NO.  
25-153  
SHEET TITLE  
SECTIONS AND  
DETAILS

SHEET NUMBER  
**S-501**




6 EQUIPMENT COVER ROOF FRAMING - 3D  
S-501


- W4x13 x 2'-3" long Bearing Beam weld To Gabled beam
- (8"x8") Steel Shim Plate For Uniform Bearing
- (2) L4 x 4x1/4 x 1'-8" Long Angles

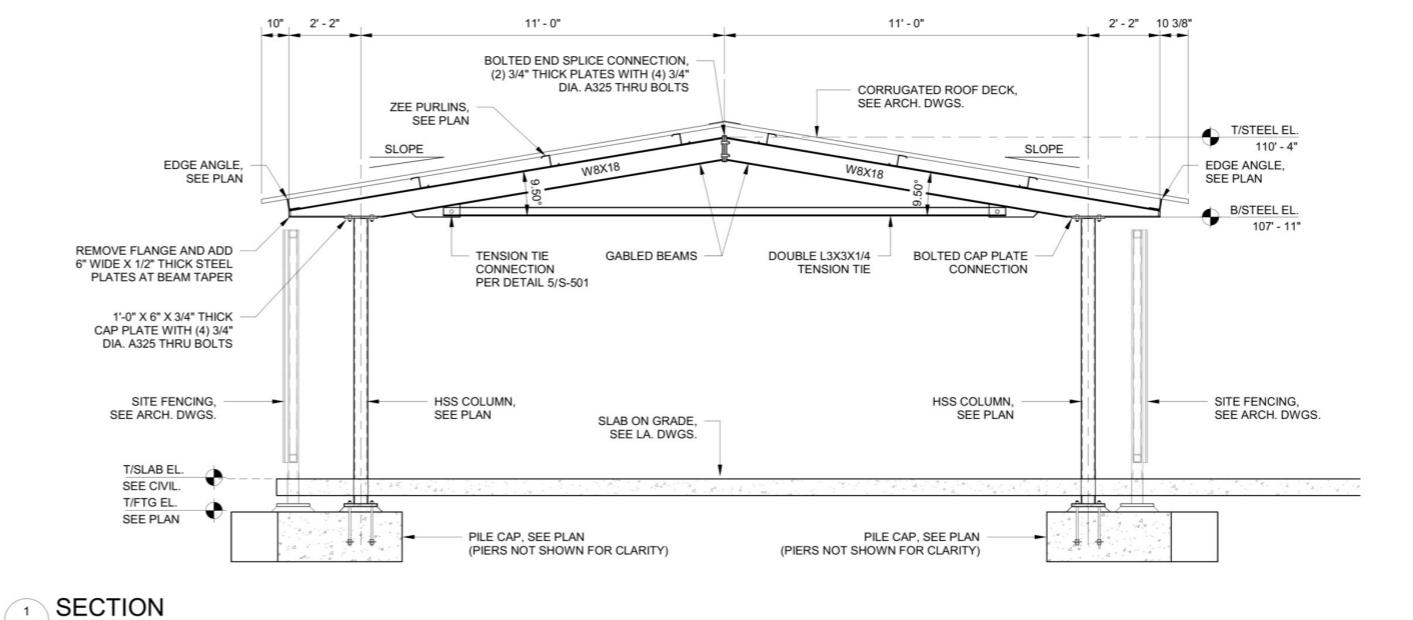


1 SECTION  
S-501 3/8" = 1'-0"

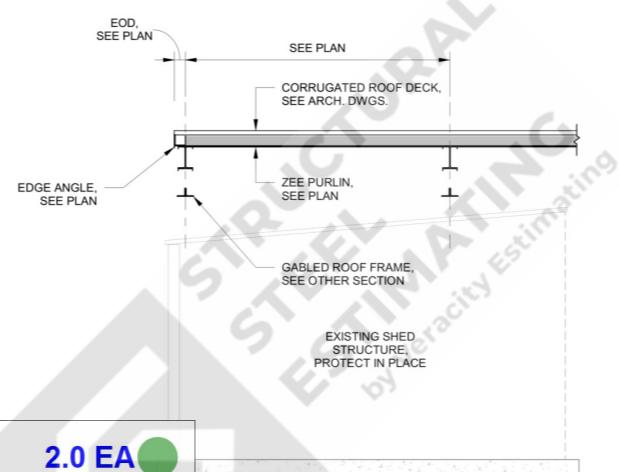


2 SECTION  
S-501 3/8" = 1'-0"

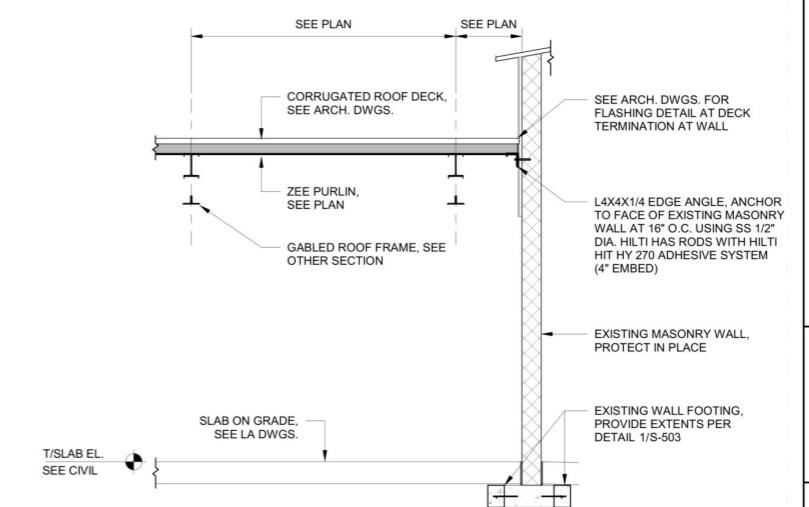

2 SECTION  
S-501 3/8" = 1'-0"

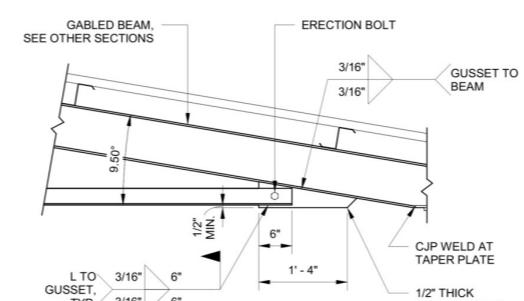

5 TENSION TIE CONNECTION  
S-501 3/4" = 1'-0"

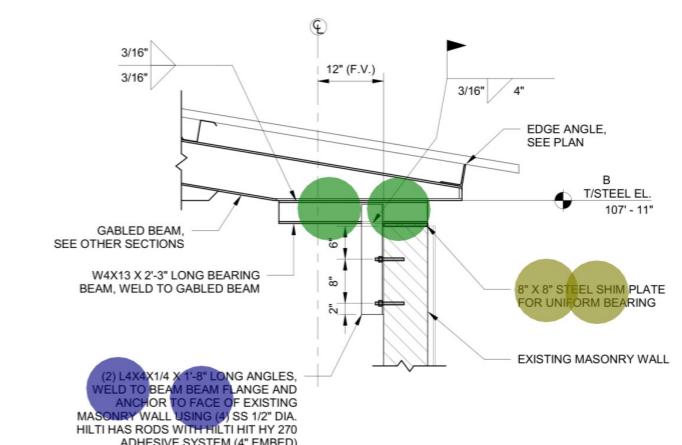

4 BEARING AT MASONRY WALL  
S-501 3/4" = 1'-0"

**DEMING PARK  
POOL  
RENOVATION**  
500 S Fruitridge Ave.  
Terre Haute, IN 47803

Owner  
City of Terre Haute  
17 Harding Avenue  
Terre Haute, Indiana 47807  
812-244 5708


Architect  
**RATIO**  
101 South Pennsylvania Street  
Indianapolis, Indiana 46204  
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Structural Engineer  
**CE Solutions**  
8770 North Street Suite 100  
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Mechanical / Electrical Engineer  
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Aquatics Designer  
**WTI**  
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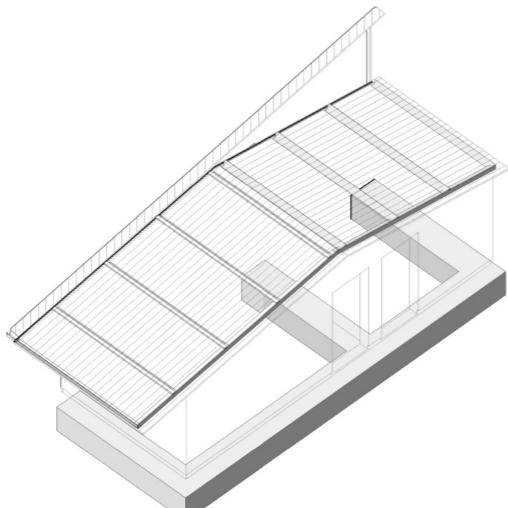
SEAL | DATE  
10/10/25  
NATHAN DANIEL BALTZ  
REGISTERED  
No. PE180033  
• PROFESSIONAL ENGINEER  
Nathan D. Baltz  
10/10/25

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1 CONSTRUCTION DOCUMENTS 10/10/25


**RATIO**  
PROJECT NO. 25-153

SECTION  
SECTIONS AND DETAILS

SHEET NUMBER  
**S-502**

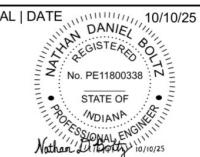

**BATHROOM ROOF FRAMING - 3D**

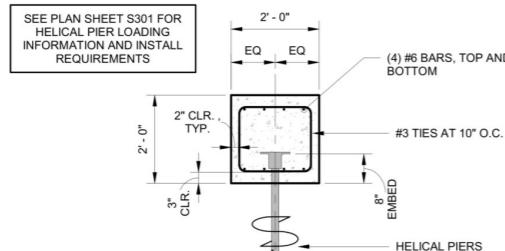


**GRADE BEAM 1**

**L4x4x1/2 ledger Angle Fasten To Existing Wall @ 16" OC**  
**L6x4x1/2x6" Long Bearing Angle Weld To Sloped Angle Anchor Into Wall BB W 3/4" Dia Cast In Bolt (6" E...**  
**L6x4x1/4 ledger Angle Fasten To Bond Beam @ 16" OC**


**30.9 FT**

**2.0 EA**

**31.0 FT**

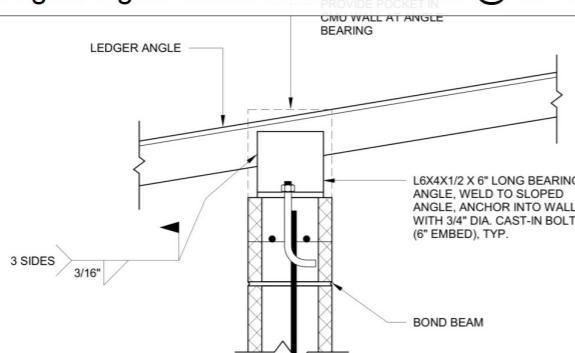


**WALL SUPPORT DETAIL**

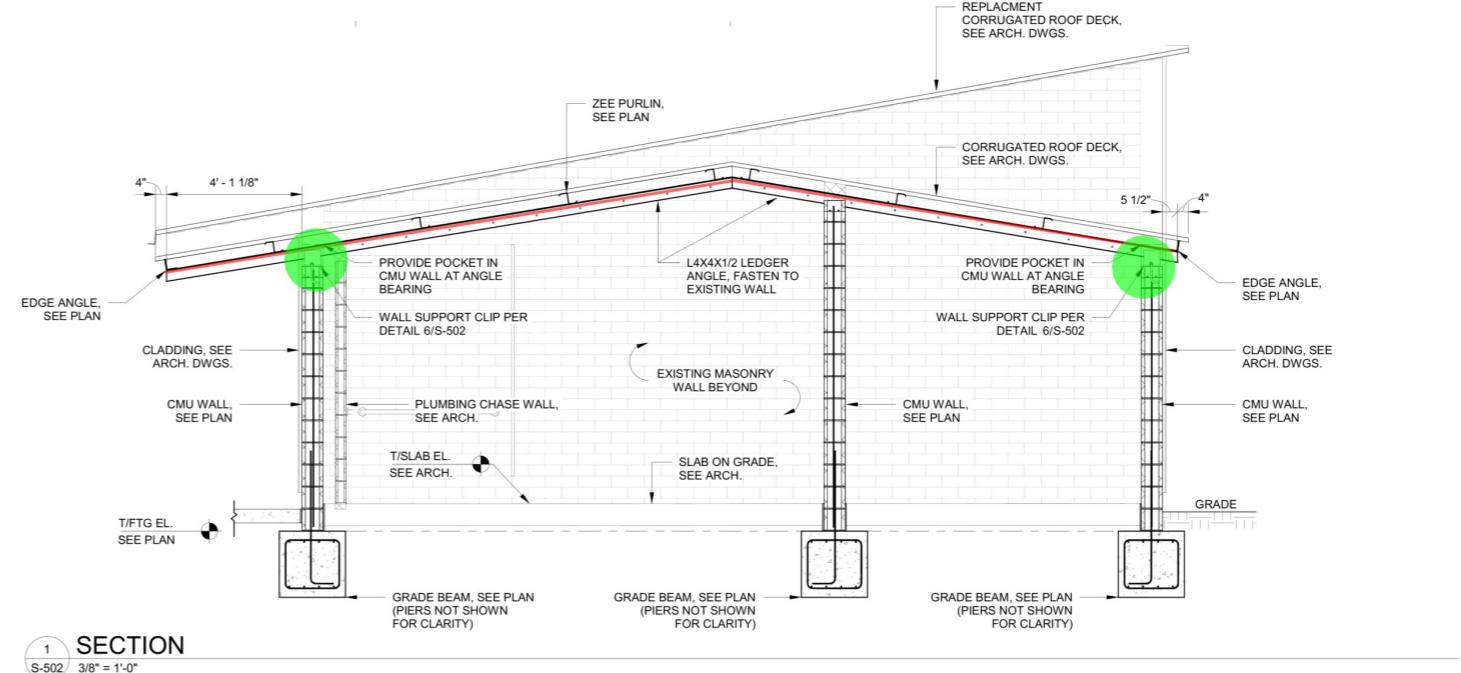


**SECTION**

S-502 3/8" = 1'-0"

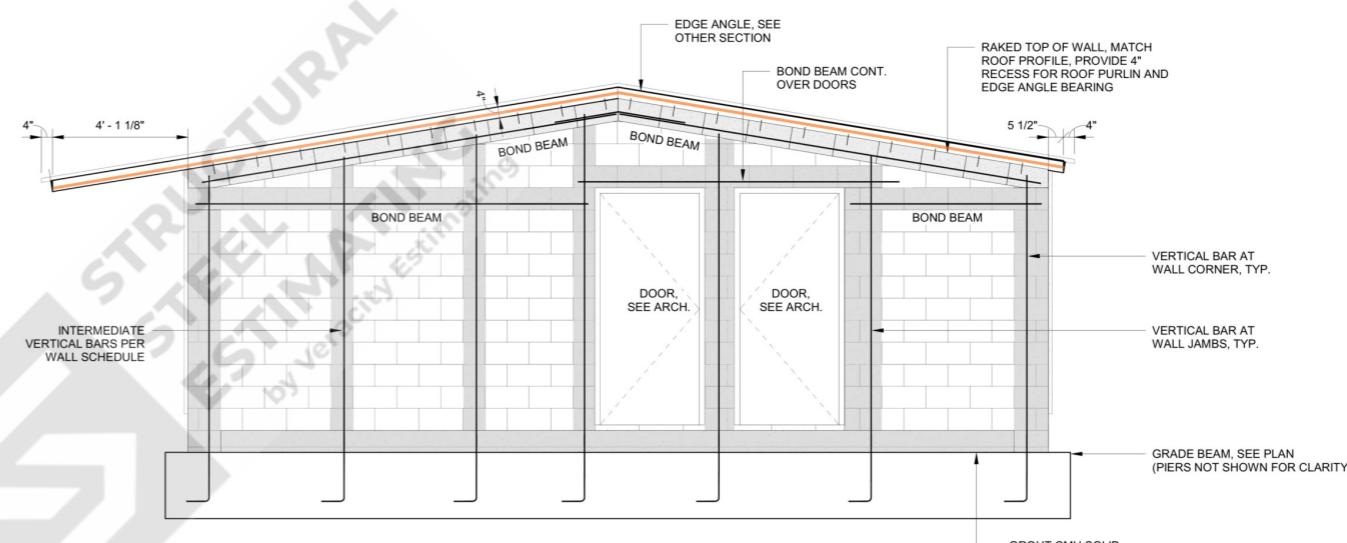

**SECTION**

S-502 3/8" = 1'-0"

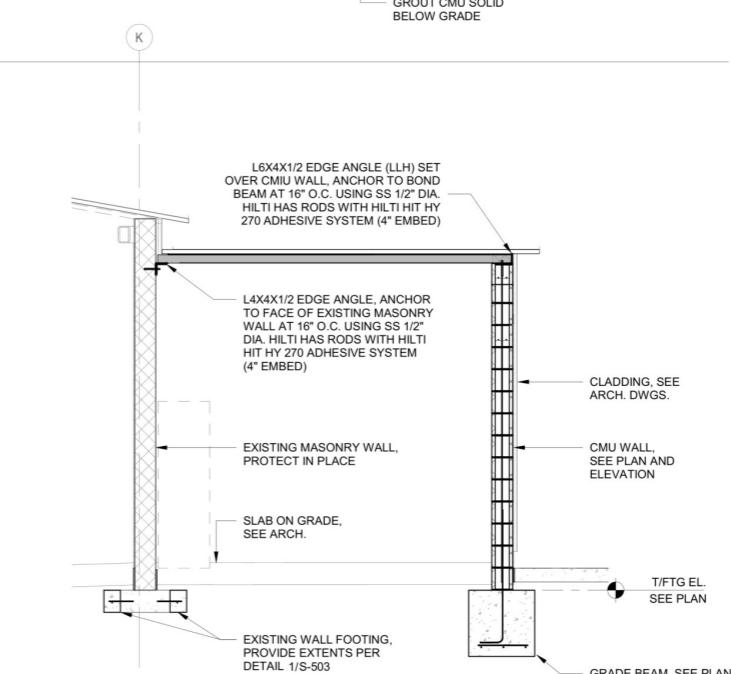

**SECTION**

S-502 3/8" = 1'-0"

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POOL  
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10/10/25  
SEAL | DATE



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PROJECT NO. 24282.000  
SHEET TITLE DOOR SCHEDULE AND DETAILS  
SHEET NUMBER A-601

**GENERAL DOOR SCHEDULE NOTES**

- THESE GENERAL NOTES APPLY TO SERIES 600 DOOR SCHEDULE DRAWINGS.
- UNDERCUT DOORS AS REQUIRED BY FINAL FLOOR FINISH.
- PROVIDE SEALANT BETWEEN HOLLOW METAL FRAME PERIMETERS AND SURROUNDING WALL CONSTRUCTION UNLESS OTHERWISE INDICATED.
- PROVIDE SEALANT BETWEEN INTERIOR AND EXTERIOR STOREFRONT FRAME PERIMETERS AND SURROUNDING WALL CONSTRUCTION UNLESS OTHERWISE INDICATED.
- GROUT FULL NEW HOLLOW METAL DOOR FRAMES IN MASONRY WALL CONSTRUCTION.
- SPOT GROUT NEW HOLLOW METAL DOOR FRAMES IN GYPSUM BOARD WALL CONSTRUCTION.
- WHERE A FIRE RATING IS INDICATED ON THE DOOR SCHEDULE, HARDWARE AND DOOR ASSEMBLY COMPONENTS SHALL MEET THE REQUIREMENTS OF THAT LABEL.
- WHERE ACOUSTICAL RATING IS INDICATED ON THE DOOR SCHEDULE, HARDWARE AND DOOR ASSEMBLY COMPONENTS SHALL MEET THE REQUIREMENTS OF THAT RATING.
- INSTALLED DOOR GLASS USING WET-GLAZING METHOD.
- REFER TO PROJECT MANUAL DIVISION 08 FOR GLAZING.
- REFER TO PROJECT MANUAL DIVISION 08 FOR HARDWARE SCHEDULE.

**DOOR SCHEDULE ABBREVIATIONS**

AL	ALUMINUM
H	HEIGHT
HM	HOLLOW METAL
PR	PAIR
T	THICKNESS
W1	WIDTH OF PANEL 1
W2	WIDTH OF PANEL 2
WD	WOOD

**DOOR SCHEDULE REMARKS**

- CASED OPENING  
REV. 07/22/09


**SLIDING GATE NOTES:**  
1. DELEGATED DESIGN TO INCLUDE FINAL ENGINEERING FASTENER SELECTION AND POSITIONING, INSTALLATION DETAILS, SHOP DRAWINGS, PRODUCT DATA SUBMITTALS, ETC. REFER TO SPECIFICATION 14000 - QUALITY REQUIREMENTS FOR ADDITIONAL INFORMATION REGARDING DELEGATED DESIGN SERVICES.

2. ALL EXPOSED STEEL, STRUCTURAL AND OTHERWISE, SHALL BE GALVANIZED AND FINISH WITH HIGH PERFORMANCE COATING, COLOR TO BE DETERMINED.

4.0 EA  
2.0 EA  
1.0 EA  
2.0 EA



**DOOR SCHEDULE**

DOOR NUMBER	PAIR	DOOR				FRAME				DETAILS	FIRE RATING	REMARKS
		W	W2	H	T	MTRL.	ELEV.	GASS	HDWR. SET	MTRL.	ELEV.	
FIRST LEVEL												
101		3'-0"		7'-0"	1 3/4"	-	F	-	01	-	F1	-
102		3'-0"		7'-0"	1 3/4"	HM	F	-	02	HM	F1	NR
104		3'-0"		7'-0"	1 3/4"	HM	F	-	03	HM	F1	NR
107		3'-0"		7'-0"	1 3/4"	HM	F	-	03	HM	F1	NR
111A		5'-0"		7'-0 3/8"	1 3/4"	-	F	-	-	-	-	-
111B		5'-0"		7'-0 3/8"	1 3/4"	-	F	-	-	-	-	-
111C	Yes	4'-0"	4'-0"	7'-0 3/8"	1 3/4"	-	F	-	-	-	-	DELEGATED DESIGN, SEE A-101 PLAN & ELEV.

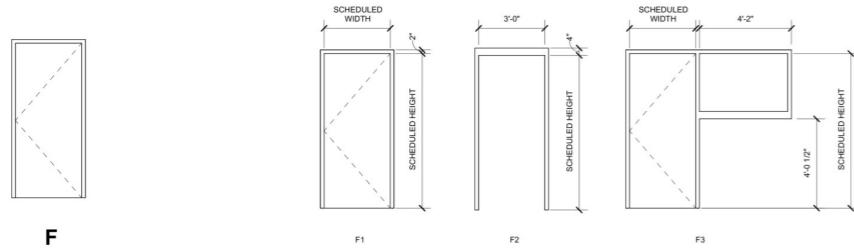

**DOOR PANEL LEGEND**


**DOOR FRAME LEGEND**

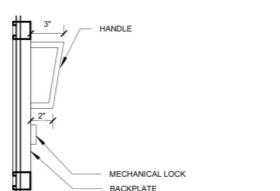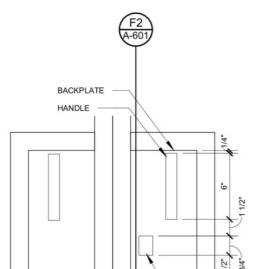


**GATE HANDLE, TYP.**  
1 1/2" = 1'-0"




**GATE HANDLE, TYP.**  
1 1/2" = 1'-0"

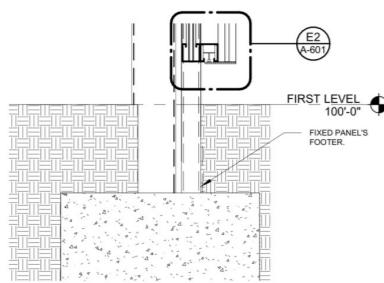


**SLIDING GATE BASE**  
1 1/2" = 1'-0"

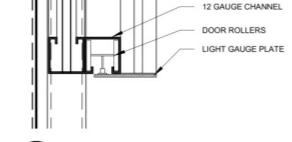


**SLIDING SYSTEM**  
3" = 1'-0"

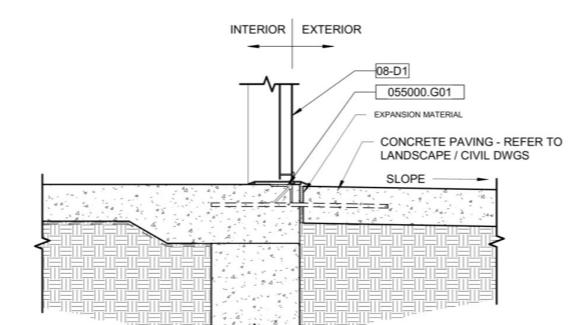

**SILL DETAIL**

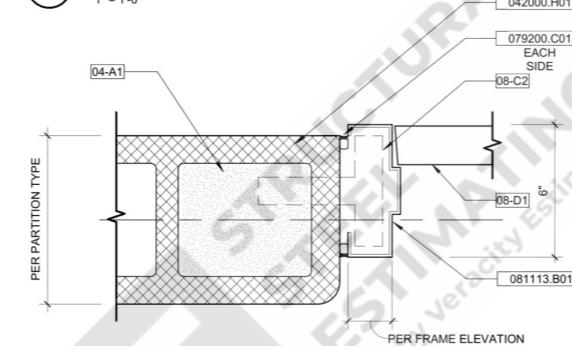

**JAMB DETAIL**

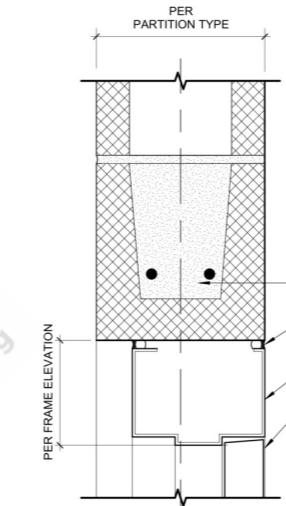


**HEAD DETAIL**

(3'-0"x7'-0") Hollow Metal Door W Frame & Hardware  
(5'-0"x7'-0") Hollow Metal Door W Frame & Hardware  
(4'-0"x7'-0") Hollow Metal Door W Frame & Hardware  
(15'-2" W x 7'-7" H) Corrugated/Perforated Metal panel W Frame & H...


**SOUTH ENTRY GATE**

1/2" = 1'-0"

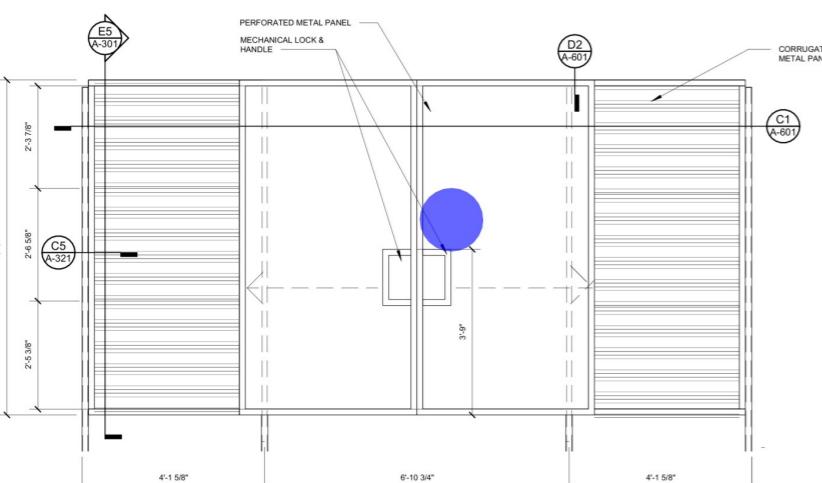

**NORTH ENTRY GATE**

1/2" = 1'-0"

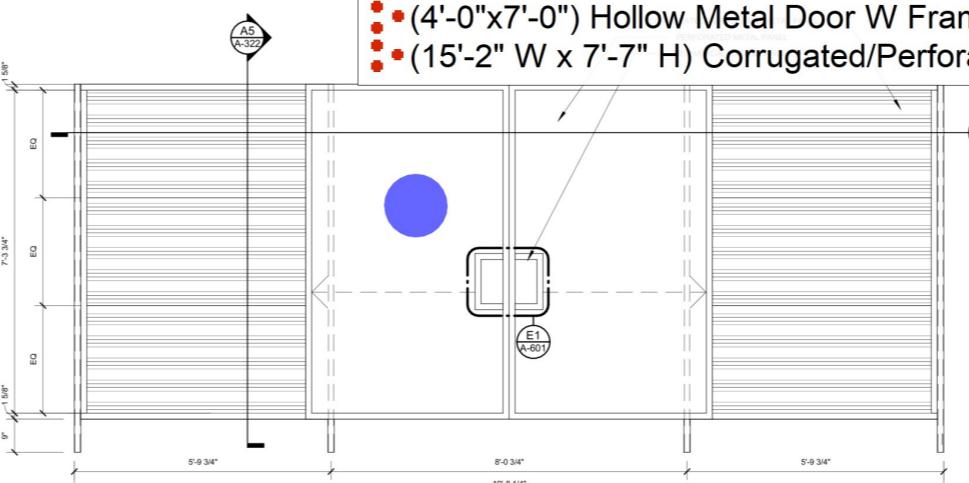

**SOUTH ENTRY GATE**

1/2" = 1'-0"